




Developments Approval for Building Work is granted pursuant to the Building Act 1975; subject to consider on the Decision Notice

| Steve mckenzie | Steve mckenzie | PROPOSED EXTENSION TO | LOT 14 FURSDEN STREET | SITE PLAN | Sign | drawing 318 | Site PLAN | Site PLAN

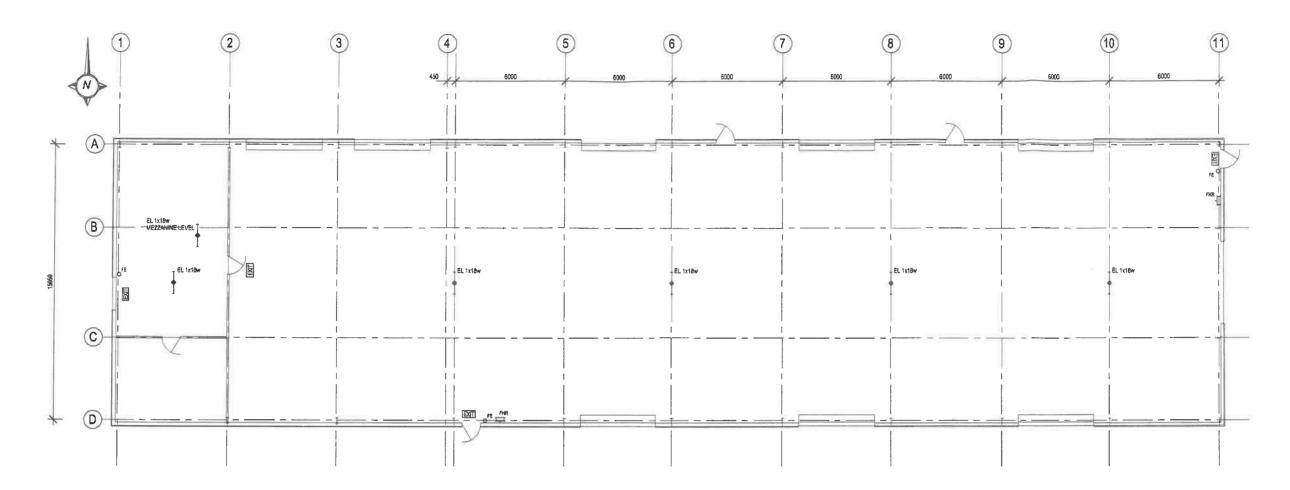

FLOOR PLAN


EL 1x18w	EMERGENCY LIGHTING 1x18W NO MAINTAINED NO DIFFUSER: 4.5 M MOUNTING HEIGHT	FIRE SERVICES				
1	Product. Code. (Stanlite Premium PBT118N or approved equal) INSTALLED IN ACCORDANCE WITH AS: 2293	REQUIRED EXIT DOORS SHALL BE FITTED WITH APPROVED ESCAPE LEVER HARDWARE.				
EXIT	EXIT SIGN ABOVE DOOR INSTALLED IN ACCORDANCE WITH AS 2293	PROVIDE FIRE EXTINGUISHER ADJACENT TO EXIT DOORS				
o ^{FE}	DRY CHEMICAL FIRE EXTINGUISHER 2450BE INSTALLED IN ACCORDANCE WITH AS 2444	LOCATION OF EMERGENCY LIGHTS ARE SHOWN FOR GUIDANCE ONLY THE INSTALLER SHALL CERTIFY THAT THE INSTALLATION COMPLIES				
FHR	38M, FIRE HOSE REEL INSTALLED IN ACCORDANCE WITH AS 2441					




70618

Development Approval for Building Work is granted pursuant to the Building Act 1975; subject to condicting on the Decision Notice

revision A: Original Issue - 04/10/05	steve mckenzie	77	PROPOSED EXTENSION TO	LOT 14 FURSDEN STREET	drawing tile FLOOR PLAN	1:100	drawn MAB	draw no. 06046	8GD
	consulting 12 turnbull street, garbutt 4814 engineer t > 4779 9392 f > 4779 9819 pty. ttd. m > 0419 689 602 acn 092 705 130	\ ' /	FOR F SHARPE	GLENELLA , MACKAY QLD - 4740		design McK	date FEB '07'	sheet no. A02	issue A

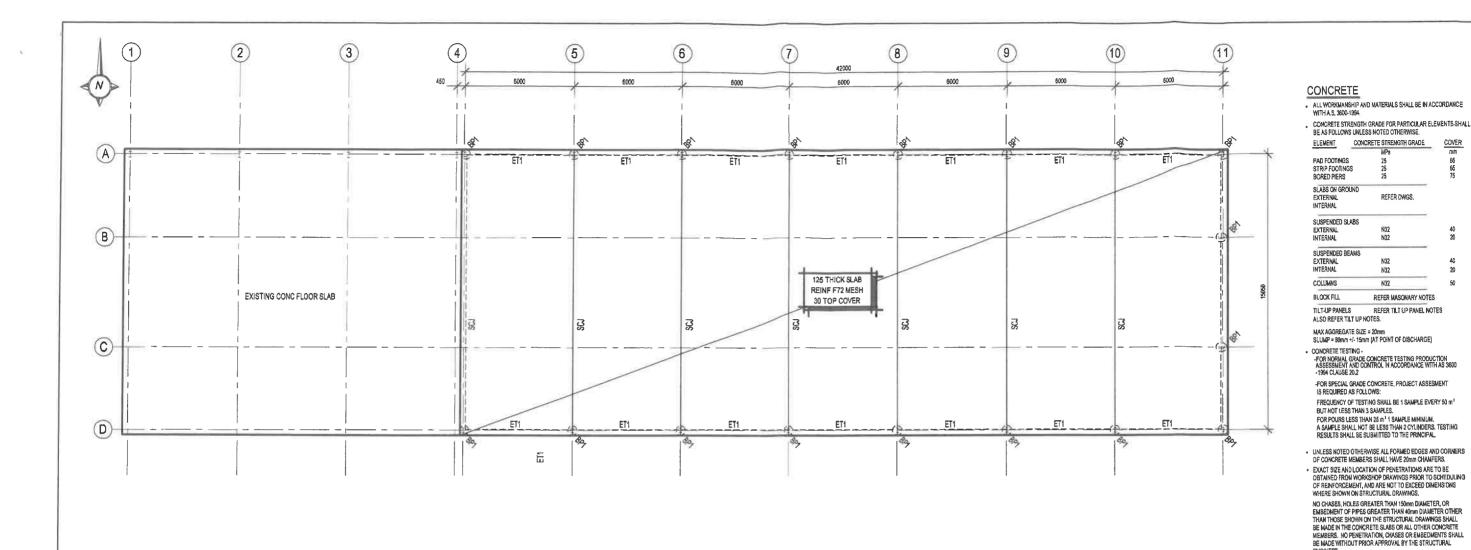

FLOOR SLAB & FOOTING PLAN

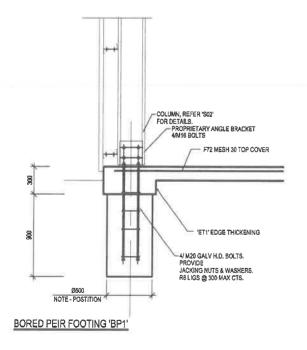

revision A: ORIGINAL ISSUE - 04/10/06

FOUNDATIONS

- . FOUND ALL STRIP AND PAD FOOTINGS INTO NATURAL MATERIAL OR CONTROLLED FILL HAVING A MINIMUM ALLOWABLE BEARING CAPACITY OF -:
- FOUND ALL BORED PIERS A MINIMUM SOCKET AS SPECIFIED ON THE DRAWINGS INTO NATURAL MATERIAL HAVING A MINIMUM ALLOWABLE BEARING CAPACITY OF : 250 kg/b.
- BORED REP RUSES SHALL BE CLEAN OF LOOSE AND WATER AFFECTED MATERIAL. BORED HER BASES SHALL BE CLEANED BY HAND OR BY CLEANOUT BUCKET. THE PRACTICE OF ADDING WATER AND SPRINING THE AUGER SHALL NOT BE PERMITTED.
- THE CONTRACTOR SHALL AT ALL TIMES OURING BORED PIER CONSTRUCTION HAVE A SUITABLE WATER PUMP ON STIE PROVIDE TEMPORARY LINERS WHERE STIE CONDITIONS REQUIRE TO PREVENT WATER INGRESS AND COLLAPSE. TEMPORARY LINERS
- . DEWATER ALL FOOTINGS. ALL CONCRETE TO FOOTINGS TO BE
- ADDITIONAL FOUNDATION PIERS AND REINFORCING WILL BE RECD.
 WHERE FOUNDING MATERIAL IS LOOSENED BY EXCAVATIONS FOR
 SERVICES, OR CONSTRUCTED ADJACENT TO FILL BATTERS OR TRENCHES FOR SERVICES. UNLESS APPROVED BY STRUCTURAL ENGINEER. EXCAVATIONS SHALL NOT EXTEND BELOW A LINE DIPPING AT 45 DEGREES AND AWAY FROM THE NEAREST UNDERSIDE CORNER OF ANY FOOTING.
- POSITIONAL TOLERANCE OF BORED PIERS ± 75 mm.

REINFORCEMENT

- · ALL REINFORCING TO BE IN ACCORDANCE WITH AS1302, 1303 & 1304
- REINFORCING LAPS TO BE (U.N.Q.) N24 - 1006 N28 - 1200 N32 - 1500 N12 - 500 N16 - 800

SUSPENDED SLAB & PANELS 420 mm (3 cross wires + 20 mm) SLABS ON GROUND FABRIC

- 220 mm (2 cross wires + 20 mm)
- CHAIR UP ALL REINFORCING AT BOOMM (MAXIMUM) CENTRES TO ENSURE CORRECT COVERS DURING CONCRETE POUR.
- REINFORCEMENT IS SHOWN DIAGRAMMATICALLY AND NOT NECESSARILY IN TRUE PROJECTION.
- DO NOT CUT REINFORCEMENT ON SITE TO CLEAR PENETRATIONS . LONG AND SHORT TERM BATTERS DISPLACE REINFORCEMENT SLIGHTLY AS NECESSARY TO CLEAR BLOCKOUTS.
- WELDING OF REINFORCEMENT IS NOT PERMITTED.
- WHERE NO STEEL IS SHOWN ON THE DRAWING AT RIGHT ANGLES TO MAIN REINFORCEMENT PLACE N12-300 DISTRIBUTION BARS U.N.O.
- ALL OPENINGS AND RE-ENTRANT ANGLES IN THE CONCRETE SHALL HAVE 20112 TOP AND BOTTOM ALONG THE CLOSING EDGE AND PROJECTING 800 PAST CORNERS.

EXCAVATIONS

- THE CONTRACTOR IS TO ENSURE STABILITY OF ALL EXCAVATIONS AND DISTING STRUCTURES DURING CONSTRUCTION. EXCAVATIONS DRAWN BEHND ELEMENTS ARE INDICATIVE ONLY. IT IS THE CONTRACTOR'S RESPONSIBILITY TO ASSESS ENCOUNTERED GROUNG CONDITIONS AND BATTER EXCAVATIONS TO MAINTAIN STABILITY.
- WHERE MATERIAL IS REMOVED FROM BESIDE OR BELOW EXISTING FOUNDATIONS ALL BACKFILL MUST BE CONCRETE. ALL BACKFILL TO TRENCHES TO BE IN ACCORDANCE WITH EARTHWORKS NOTES.
- EXISTING PAVEMENTS MUST NOT BE LOADED DURING EXCAVATION FOR A DISTANCE OF 3m FROM EXCAVATION EDGE.
- REFER FOUNDATION NOTES IF SERVICES ARE LOCATED CLOSE
- LONG TERM 4H: 1V U.H.O. REFER SOIL REPORT
- CERTIFICATION

Decision Notice Nº 70618

is granted purguent to the Building Act 1975; subject to conditions on the Decision Notice

Development Approval for Euliding Work

steve mckenzie B.E.(hore), CPENG, MIEAuet, RPEQ consulting 12 lumbull street, garbutt 4814 engineer t > 4779 9392 1 > 4779 9819 engineer t > 4779 9392 r > 4 pty. ltd. m > 0419 669 602

PROPOSED EXTENSION TO EXISTING WAREHOUSE FOR MACKAY CABINETMAKERS LOT 14 FURSDEN STREET GLENELLA , MACKAY QLD - 4740

FLOOR SLAB & FOOTINGS PLAN & DETAILS

1:100 0604646GD issue sheet no. S01 SEPT '06

- CONSTRUCTION RREAK LOCATIONS SHALL BE APPROVED BY
 - THE STRUCTURAL ENGINEER PRIOR TO CONSTRUCTION. . THE FACE OF ALL CONCRETE AGAINST WHICH NEW CONCRETE

 SERVICES SHALL NOT PENETRATE BEAMS UNLESS APPROVED IN WRITING BY PRINCIPALS REPRESENTATIVE CONDUITS CAST INTO CONCRETE MEMBERS SHALL BE SPACED AT MAX. DISTANCE POSSIBLE AND UNDER NO CIRCUMSTANCES CLOSER THAN A CLEAR SPACING OF TWICE THE LARGER CONDUIT DIAMETER FROM PARALLEL REINFORCEMENT OR ANY

OTHER CONDUIT, NO CONDUITS SHALL BE PLACED WITHIN THE

BREAK BOND BETWEEN ALL LOAD BEARING MASONRY (NON REINFORCED) AND CONCRETE WITH MINIMUM OF TWO LAYERS OF SUPER ALCOR AND OR 2 LAYERS FC SHEET OR APPROVED EQUIVALENT.

COVER OF THE REINFORCEMENT.

REFER DWGS


N32


REFER MASONARY NOTES


- IS TO BE CAST SHALL BE CAST VERTICAL OR HORIZONTAL AND TO BE THOROUGHLY SCABBLED.
- ALL CONCRETE SURFACES ARE TO BE CURED FOR SEVEN DAYS AFTER CASTING USING A CURING COMPOUND THAT CONFORMS TO THE RELEVANT AUSTRALIAN STANDARDS AND IS COMPATIBLE WITH THE SPECIFIED FINISHES, U.N.O.

FLOOR SLABS:

- . THE SLABS ON GROUND HAVE BEEN DESIGNED WITH MINIMAL REINFORCEMENT TO CONTROL CONCRETE SHRINKAGE IN ORDER TO PROVIDE AN ECONOMIC SLAB. SOME SHRINKAGE CRACKING IN THE SLAB IS TO SE EXPECTED.
- THE SLABS HAVE BEEN DESIGNED AS A FLOATING SLAB. HEINCE MOVEMENT IN THE SUBGRADE WILL RESULT IN VERTICAL & CURVATURE MOVEMENTS IN THE SLAR ALONG WITH SOME MINOR CRACKING. EXPECTED MOVEMENT TO BE IN THE RANGE

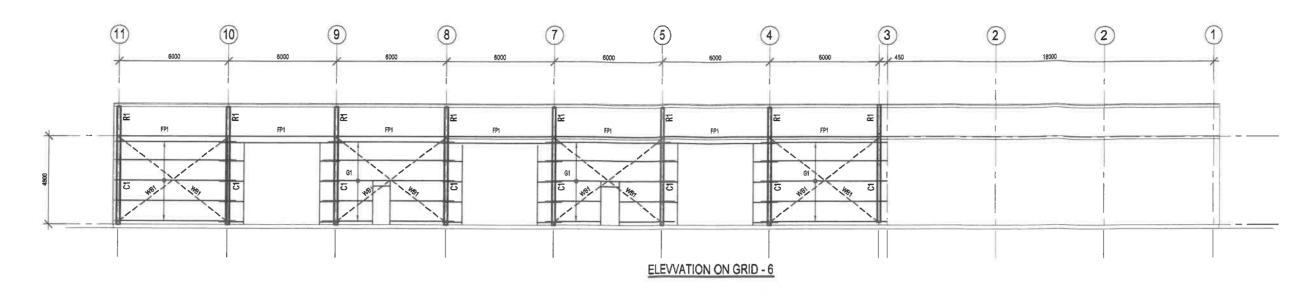

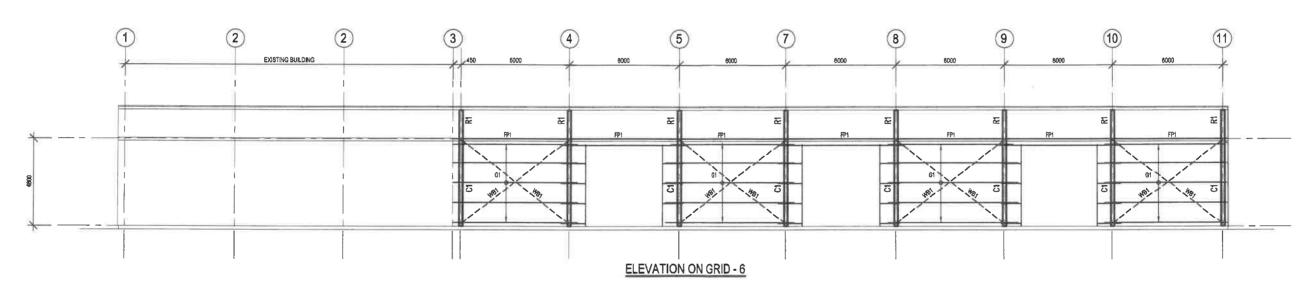

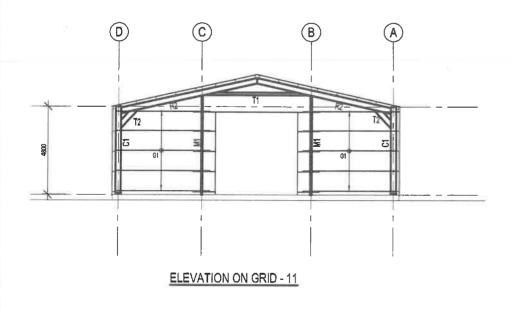



70618

Development Approval for Building Work is granted pursuant to the Building Act 1975; subject to conditions on the Decision Notice

revision A: ORIGINAL ISSUE - DUYONG	steve mckenzie B.E.(hone), CPENQ., MIEJust, RPEQ	project PROPOSED EXTENSION TO		drawing title WALL FRAMING ELEVATIONS	scale 1:100 , 1 : 50	drawn MAB	drew no. 06046GE	,D
	consulting 12 turnbull street, garbutt 4814 engineer t > 4779 9392 f > 4779 9819 pty, ltd. m > 0419 889 802 acn 082 705 130	EXISTING WAREHOUSE FOR MACKAY CABINETMAKERS	GLENELLA , MACKAY QLD - 4740		design McK	date SEPT '06	sheet no. is	issue A